## MIDDLE CONCHO BOAT RAMP IMPROVEMENTS MIDDLE CONCHO PARK

## 3399 MIDDLE CONCHO DRIVE SAN ANGELO, TEXAS







ENGINEERING, LLC

SURVEYING + ENVIRONMENTAL + LAB/CMT

TOE SOUTH ABE STREET

PHONE: 325.655.1288

SAN ANGELO, TEXAS 76903

FAX: 325.657.8189

FIRM REGISTRATION NUMBER F-7608

Www.skge.com



MIDDLE CONCHO BOAT RAMP IMPROVEMENTS MIDDLE CONCHO PARK SAN ANGELO, TEXAS

COVER SHEET

DWG BY:
RTG
FEB. 6, 2020

JOB NO.
19-E-0890
SCALE:
NONE

REVISIONS

DWG. DATE:
FEB. 6, 2020

SHEET NO.
CO.O

**TABLE OF CONTENTS:** 

CO.1 TOPOGRAPHIC SURVEY

& DEMO PLAN

C1.1 SITE PLAN

**C2.1 GRADING PLAN** 


**C3.1 UTILITY PLAN** 

**C4.1 EROSION CONTROL WORKMAP** 

**C5.1 CIVIL DETAILS** 

**C5.2 UTILITY DETAILS** 

**A1.1 BUILDING DETAILS** 

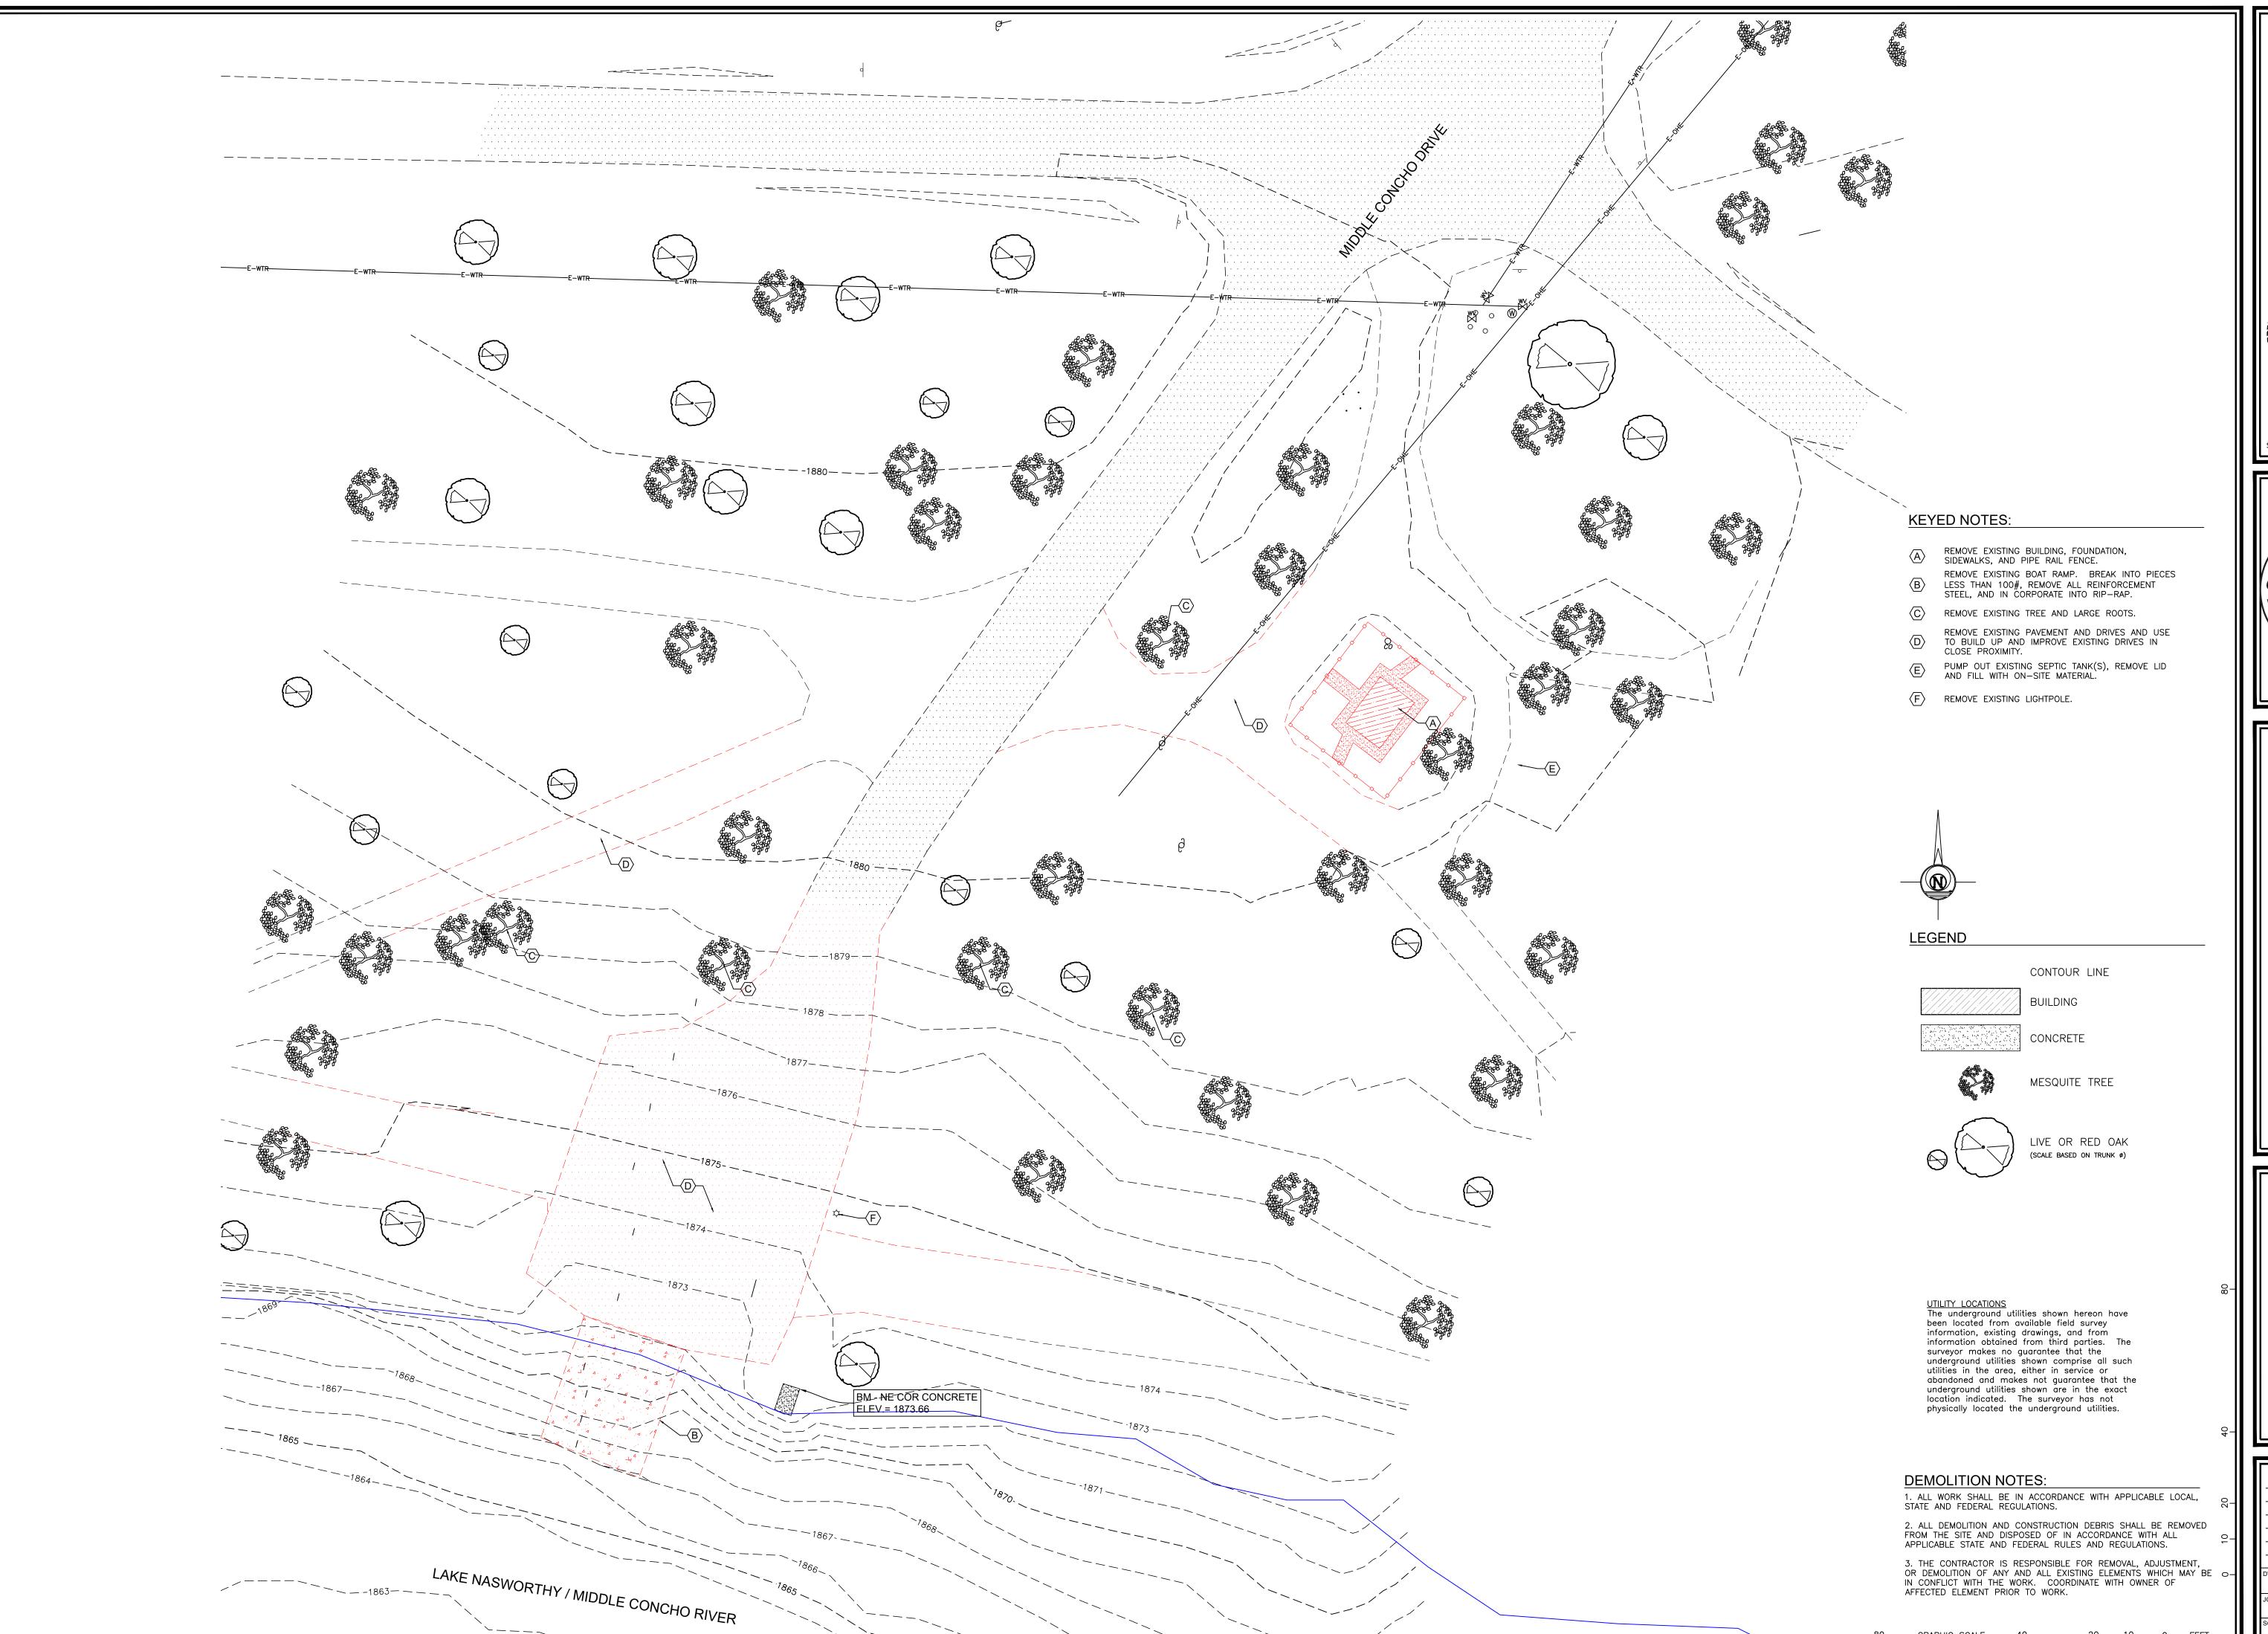

RUSSELL T. GULLY
87727
CENSE
CONAL
THE SEAL APPEARING ON THIS
DRAWING WAS AUTHORIZED BY
RUSSELL T. GULLY, P.E. 87727
SKG ENGINEERING, LLC #F-7608

THE CIATOF SAN PEXAS \* OF SAN PEXAS

DLE CONCHO BOAT
AP IMPROVEMENTS
DLE CONCHO PARK
N ANGELO TEXAS

OPOGRAPHIC SURVEY

&
DEMO PLAN

WG BY:
EG FEB. 6, 2020
DB NO.
19-E-0890

1"=20'



ENGINEERIN

SURVEYING • ENVIRONMENT

TOG SOUTH ABE STREET

SAN ANGELO, TEXAS 76903
FIRM REGISTRATION NUMBER F.

Www.skge.com



MIDDLE CONCHO BOAT
RAMP IMPROVEMENTS
MIDDLE CONCHO PARK
SAN ANGELO TEXAS

SITE PLAN

REVISIONS

WG BY:

EG

DWG. DATE:


FEB. 6, 2020

SHEET NO.

19-E-0890

CALE:

1"=20'

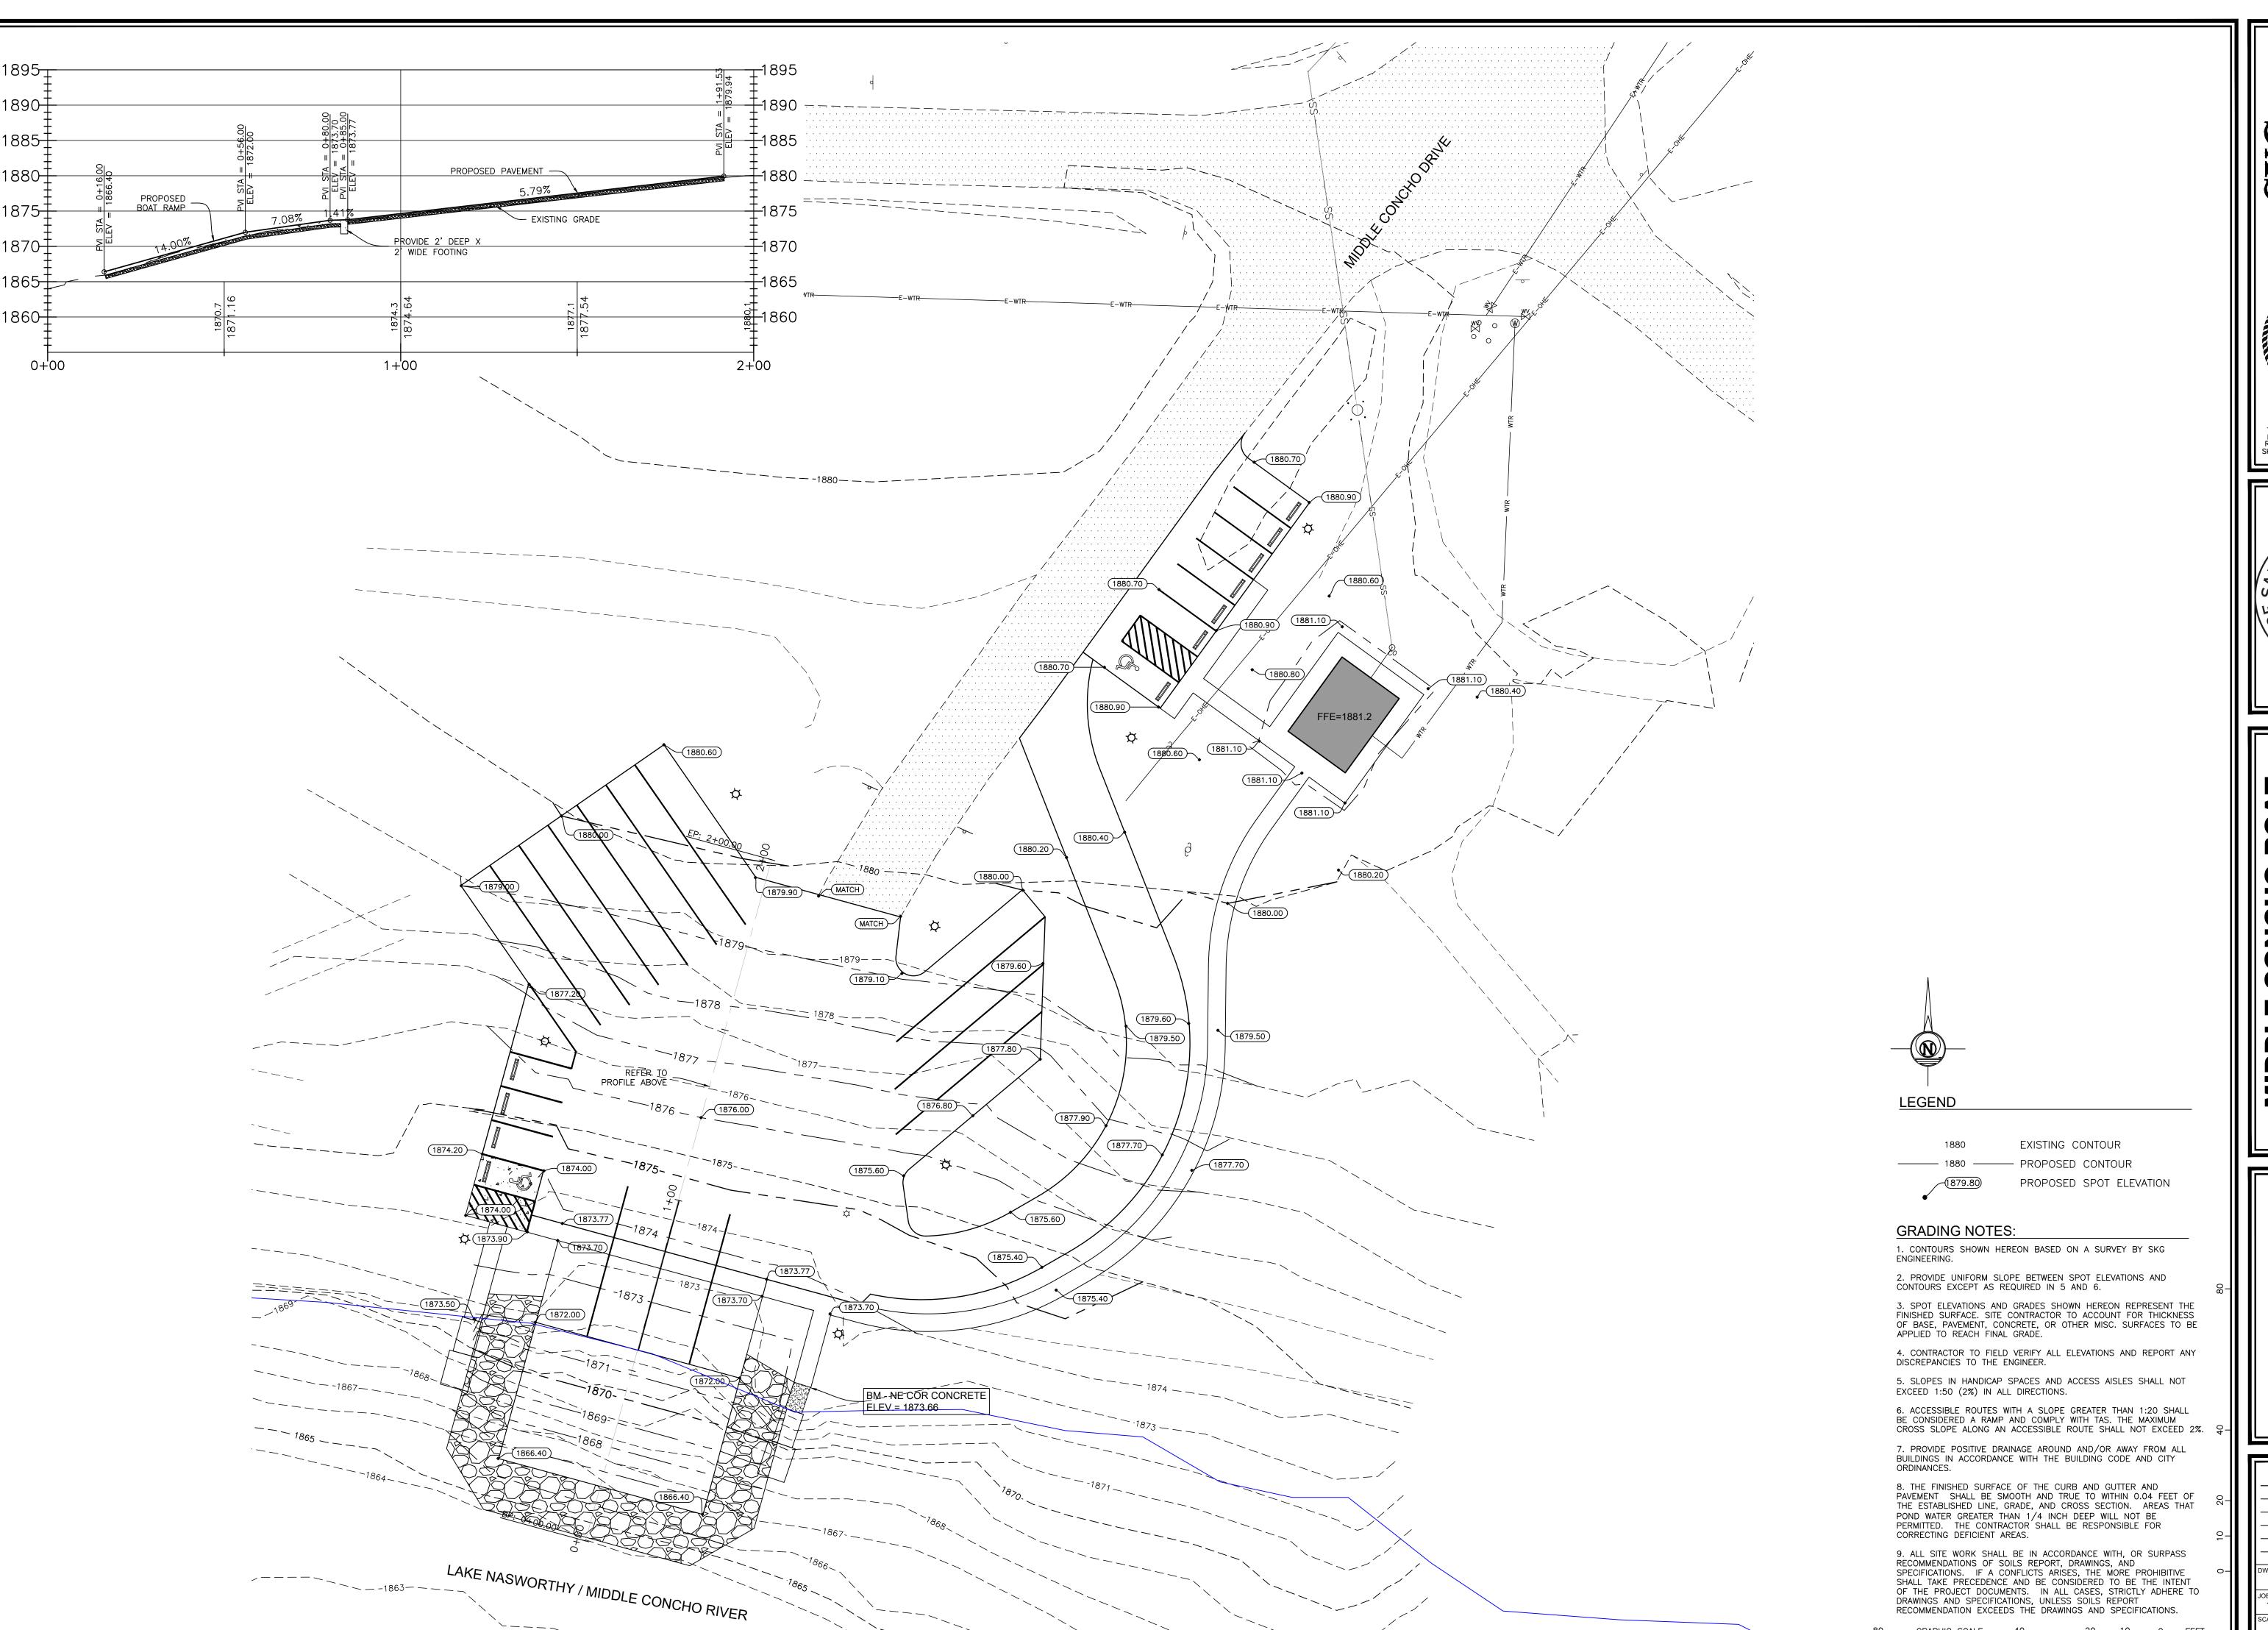



FEB. 6, 2020 SHEET NO. 19-E-0890

C:\Engineering\2019\19E0890 COSA\_Middle Concho Park Impro\CIVIL.dwg

1"=20'

SHALL TAKE PRECEDENCE AND BE CONSIDERED TO BE THE INTENT OF THE PROJECT DOCUMENTS. IN ALL CASES, STRICTLY ADHERE TO DRAWINGS AND SPECIFICATIONS, UNLESS SOILS REPORT

RECOMMENDATION EXCEEDS THE DRAWINGS AND SPECIFICATIONS.







# MIDDLE CONCHO BOAT RAMP IMPROVEMENTS MIDDLE CONCHO PARK SAN ANGELO, TEXAS

TII ITY PI AN

REVISIONS

BY:

RTG

FEB. 6, 2020


NO.

SHEET NO.


C3.1

C:\Engineering\2019\19E0890 COSA\_Middle Concho Park Impro\CIVIL.dwg

19-E-0890 SCALE: 1"=20'

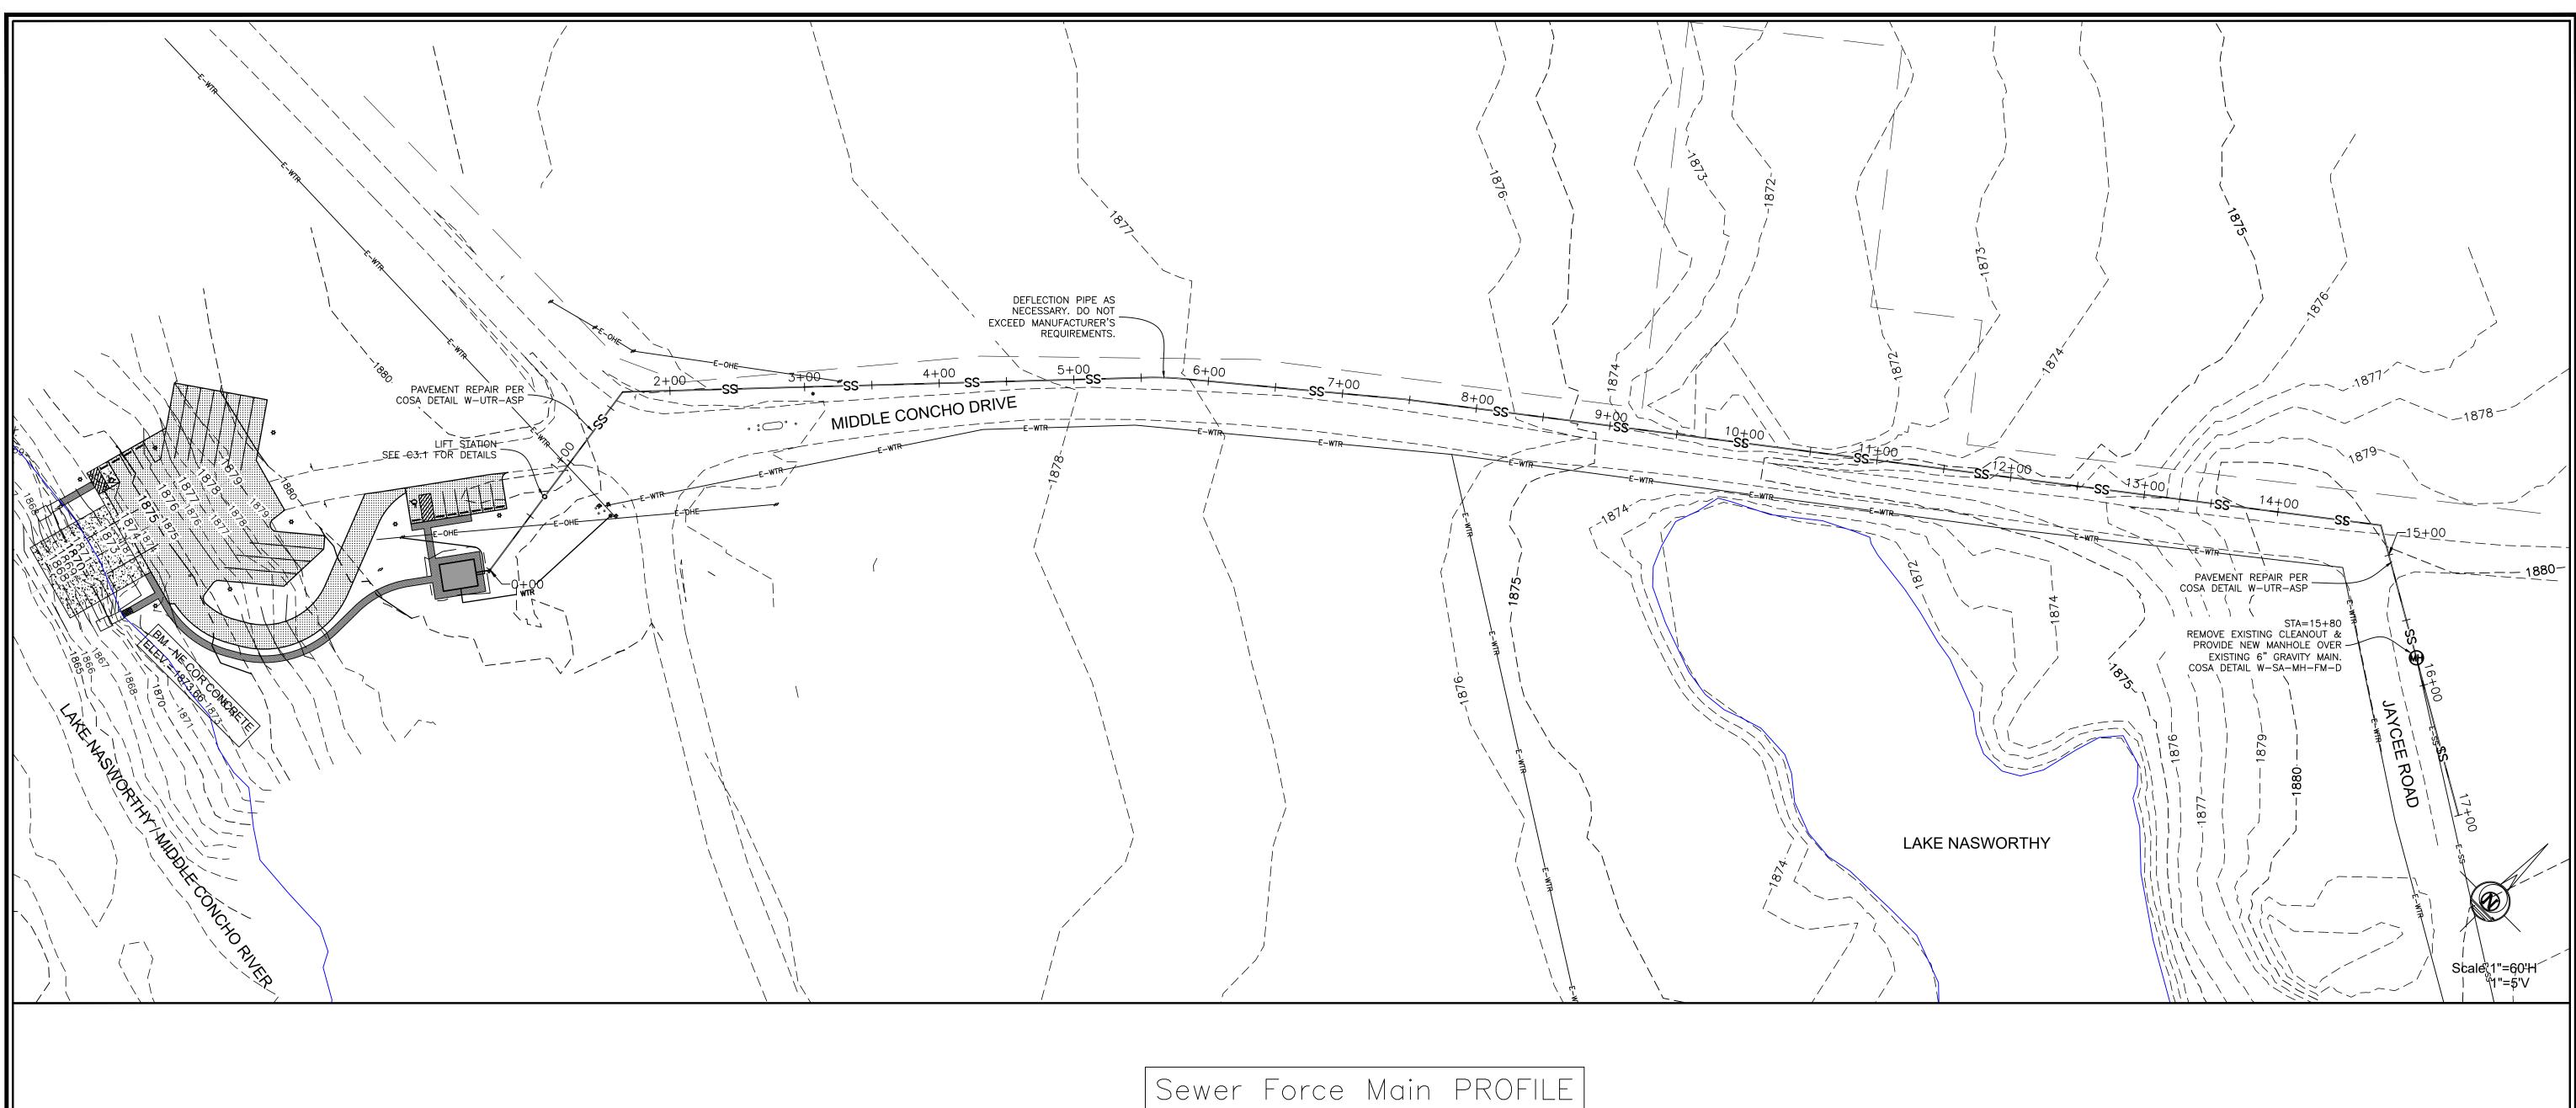



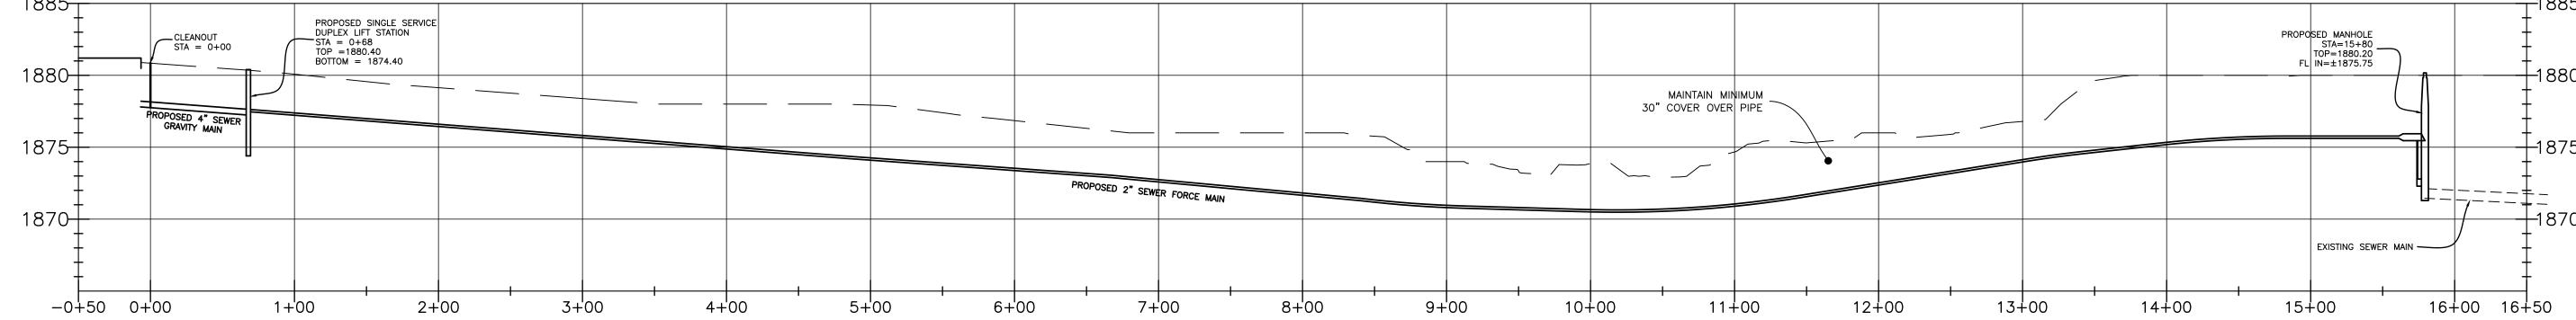

#### **GENERAL NOTES:**

1. All work shall be performed in accordance with the City of San Angelo Water Utility's Standards.

2. Municipal water lines are to be constructed in accordance with the 'Rules and Regulations for Public Water Systems', Section 290, as adopted by the TCEQ.

3. Sanitary sewer lines are to be constructed in accordance with the Chapter 217, 'Design Criteria for Sewerage Facilities' as adopted by the TCEQ.

4. Where water lines and new sewer lines are installed with a separation distance closer than nine feet (i.e., water lines crossing wastewater lines, water lines paralleling wastewater lines, or water lines next to manholes) the installation must meet the requirements of 30 TAC 217.53 (Design of Sewage Systems) or 30 TAC 290.44(e) Water Hygiene).

5. Existing line locations are shown for the convenience of the contractor in accordance with the best information available, but is not guaranteed to be correct or complete. 6. The contractor is responsible for verifying the exact size, type, and location of all utilities and protecting and repairing the same at no additional cost to the owner.

7. Prior to beginning work, the installer shall be responsible for ensuring that adequate horizontal and vertical controls are in place for locating the utility line.

8. The contractor is responsible for adjusting the tops of all utility features to finished grade after the site work is

9. The contractor shall provide the engineer with a set of As—Built drawings showing the constructed flowline and top of manhole elevations and any deviations from the plans.

10. For sewer services with less than 24" of cover, the contractor shall either video the line or run a mandrel through the line to verify integrity after the street subgrade is compacted and before the street is paved.

11. The contractor shall notify the City of San Angelo Water Utilities Department prior to initiating any on—site water utilities related work.

#### CITY OF SAN ANGELO DEPARTMENT OF PUBLIC WORKS

☐ ACCEPTED ☐ ACCEPTED AS NOTED

City of San Angelo Water Utilities Department Contact Information:

Engineering Services Division:

(325) 657-4201

Drawing as to design only. Dimensions and location are not verified, contractor to verify as to plans and/or installation requirements.


DWG. DATE: FEB. 6, 2020 EG SHEET NO. 19-E-0890 1"=60'

C:\Engineering\2019\19E0890 COSA\_Middle Concho Park Impro\CIVIL.dwg



## E CONCHO E CONCHO E CONCHO ANGELO, TE MIDDL MIDDI

SANITARY SEWER PLAN/PROFILE

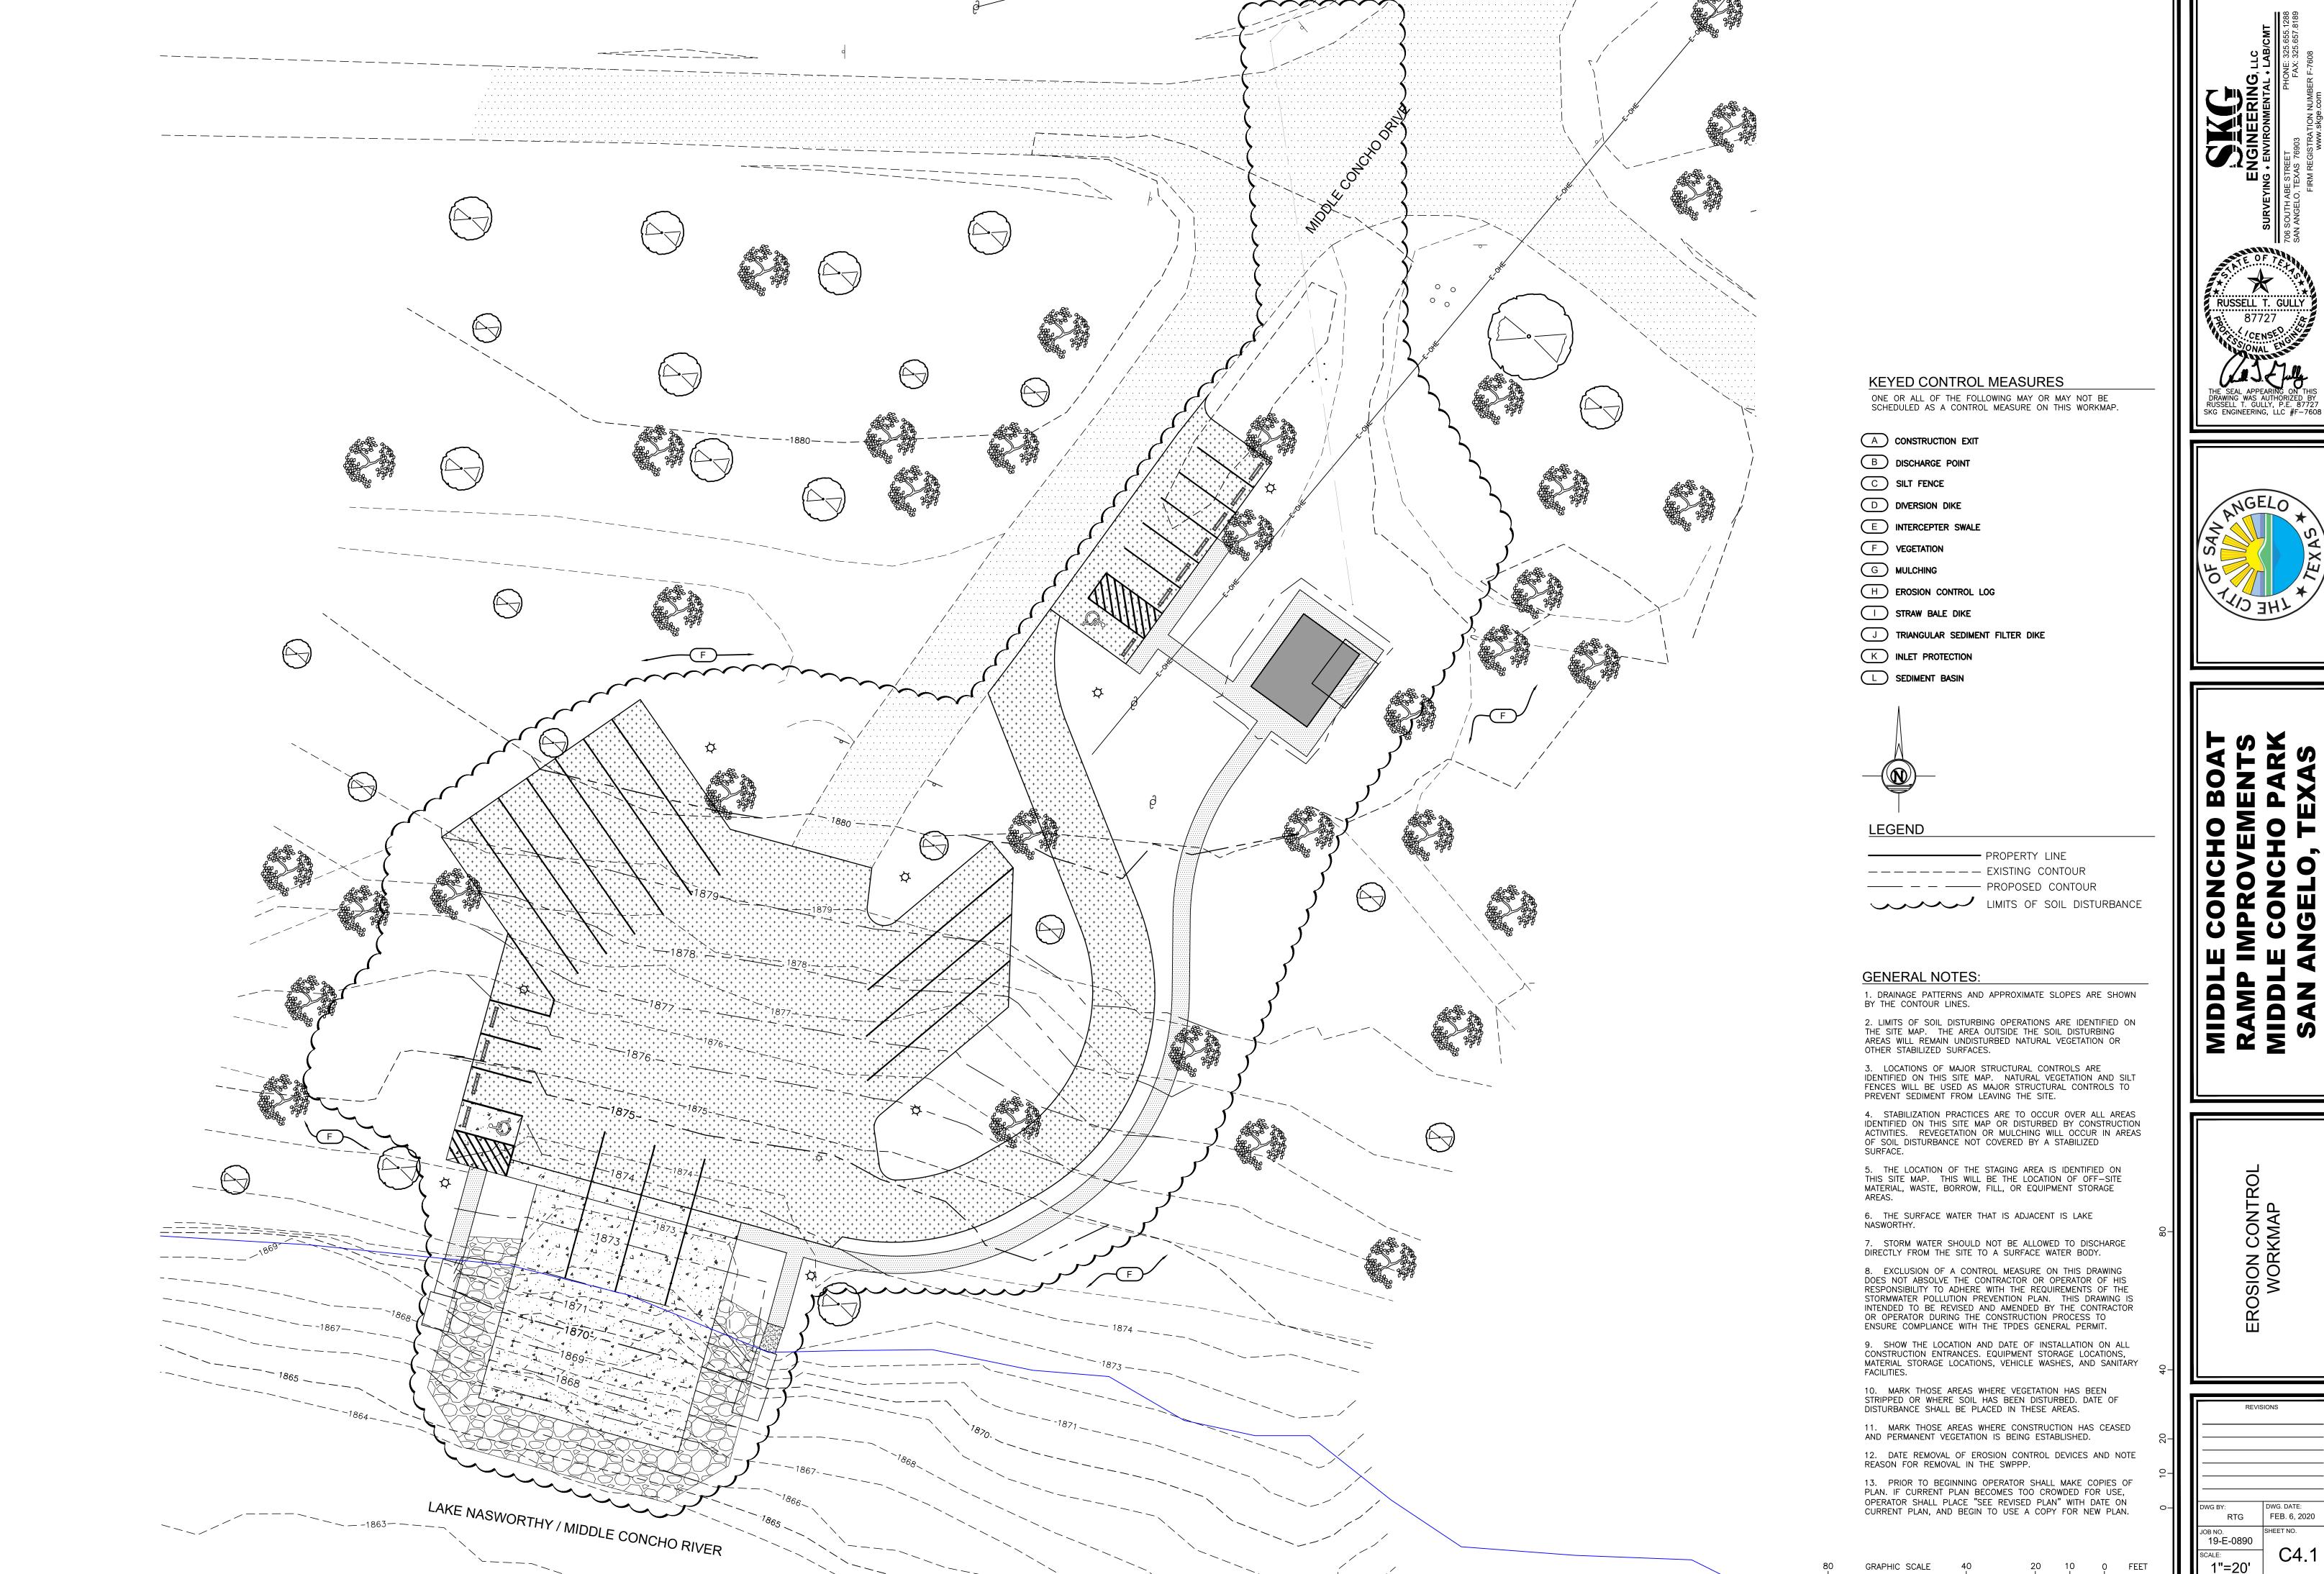



C:\Engineering\2019\19E0890 COSA\_Middle Concho Park Impro\CIVIL.dwg

등 는 , ' <del>U</del> O ZO

SION CON-

FEB. 6, 2020 RTG

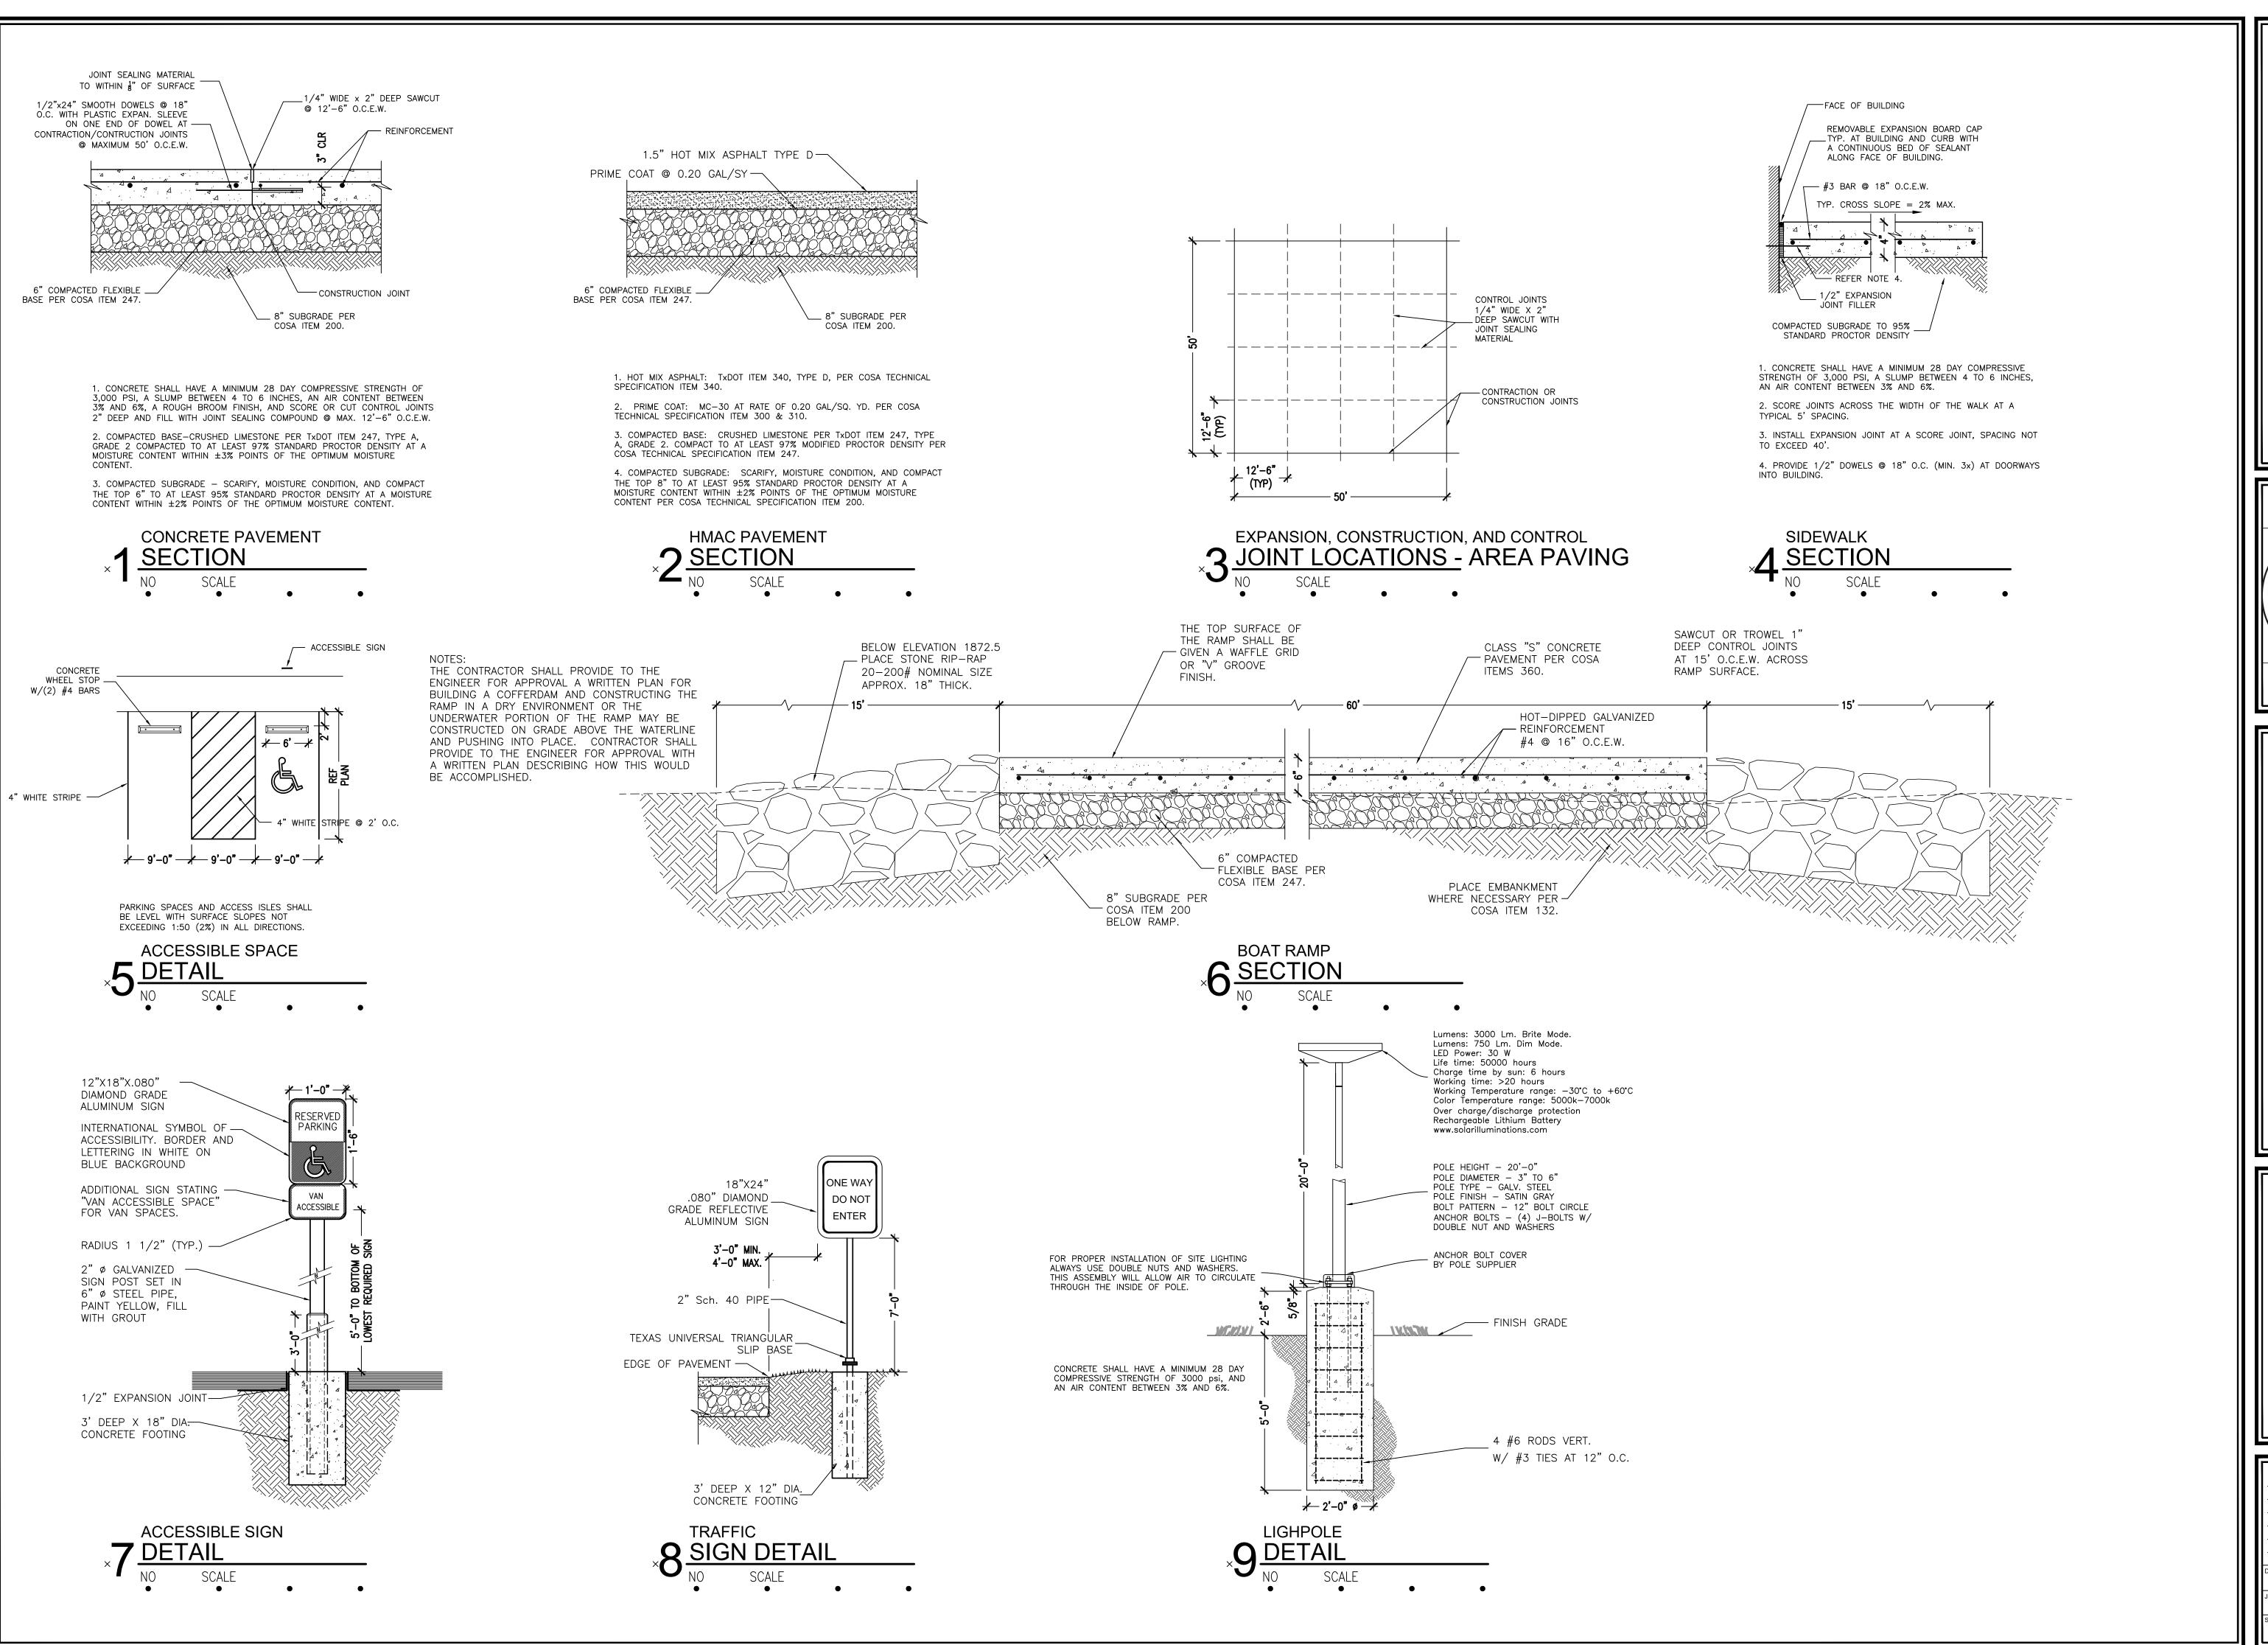

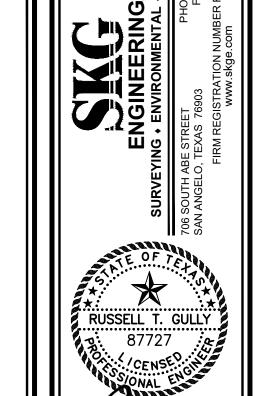




### MIDDLE CONCHO BOAT RAMP IMPROVEMENTS MIDDLE CONCHO PARK SAN ANGELO, TEXAS


SITE DETAILS


DWG BY:
RTG
PEB. 6, 2020


JOB NO.
19-E-0890
SCALE:
VARIES

REVISIONS
DWG. DATE:
FEB. 6, 2020
SHEET NO.
C5.1

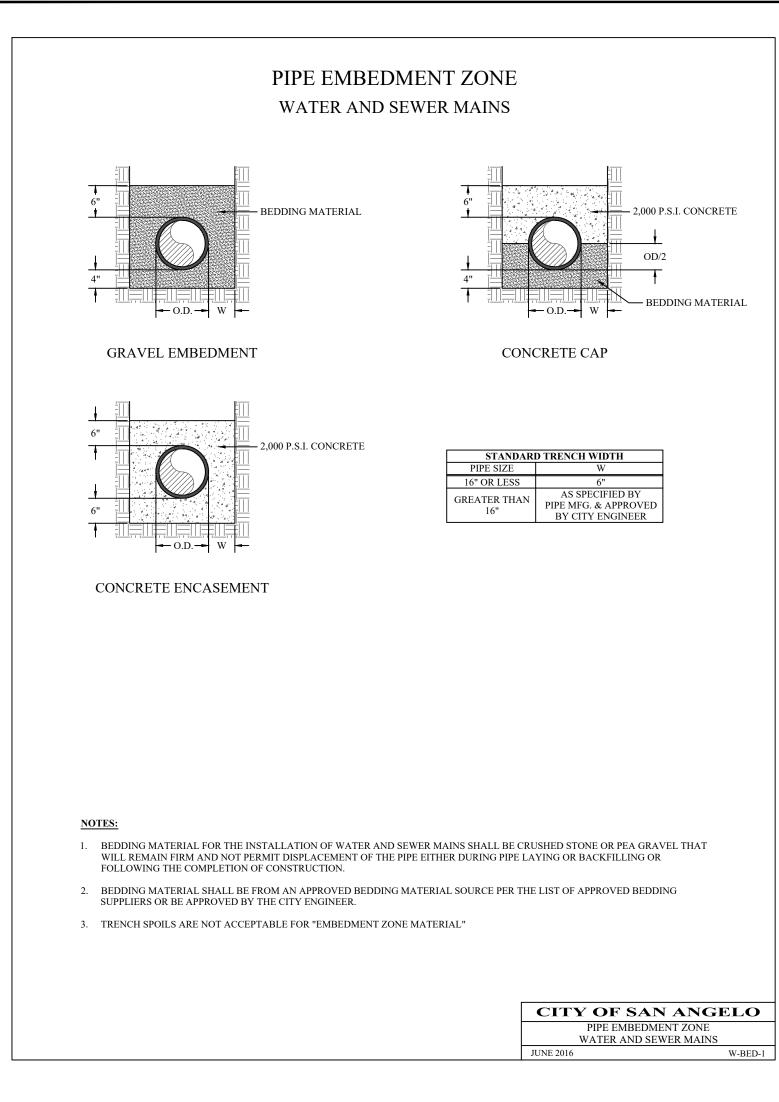

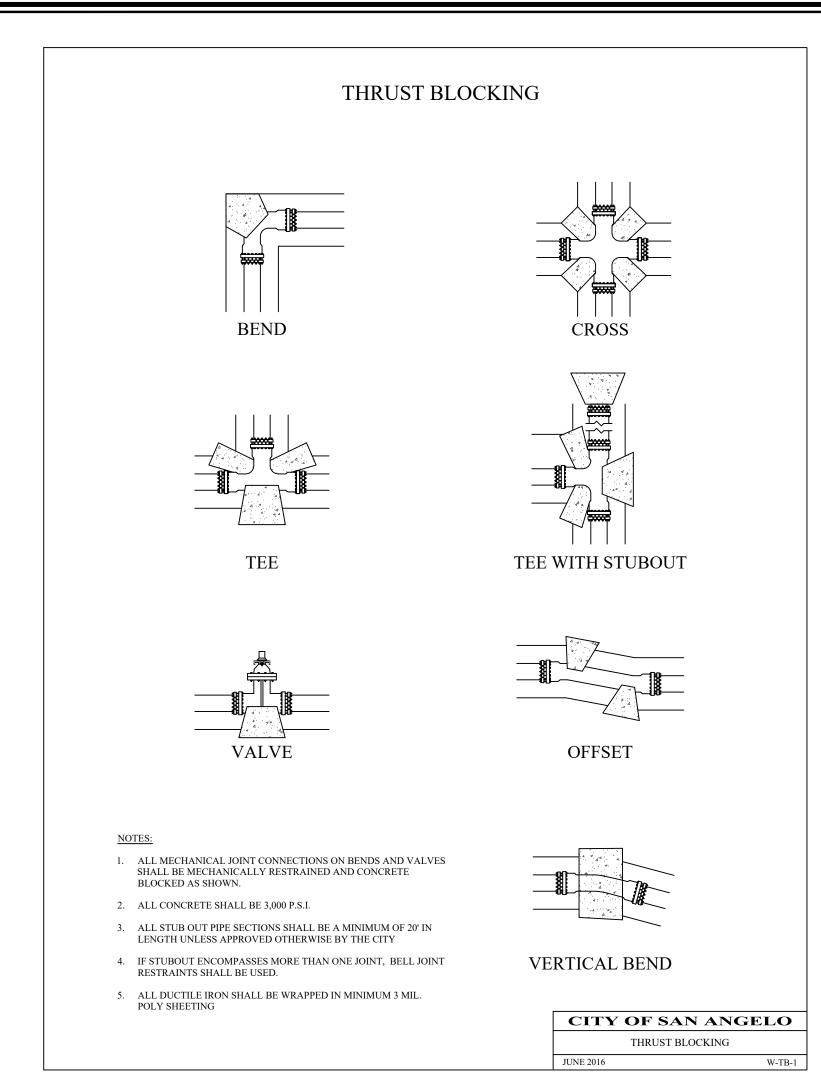


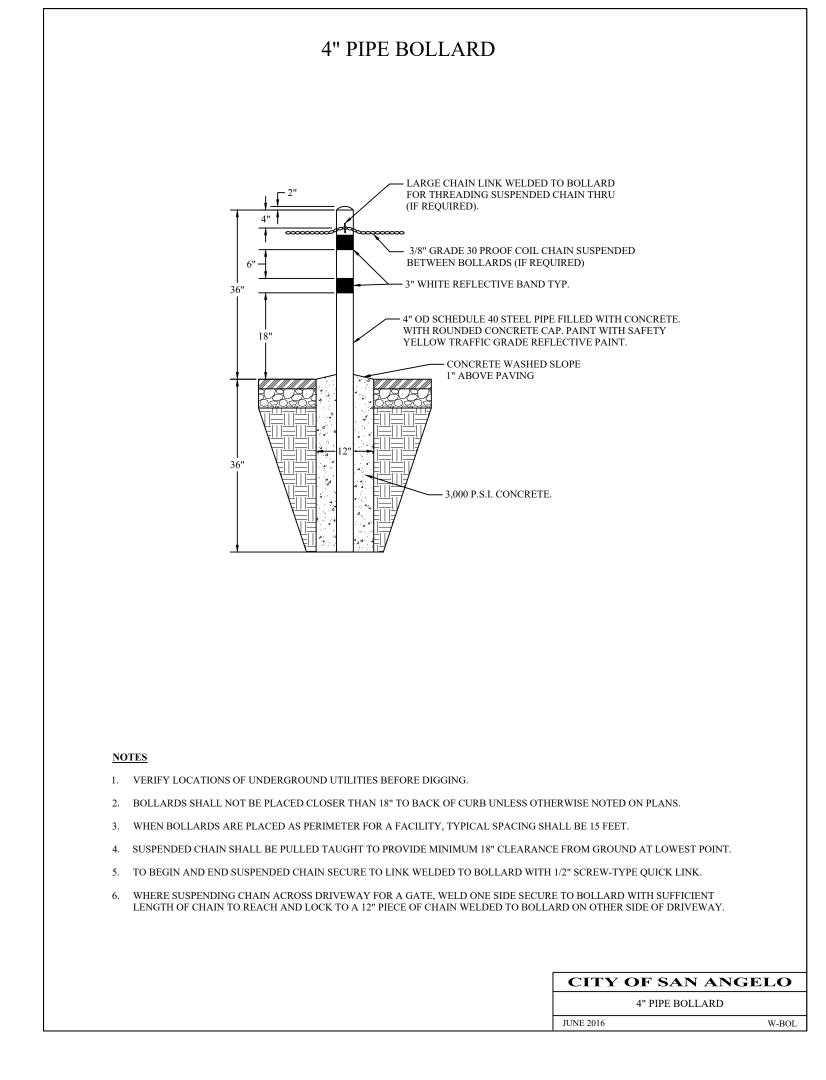


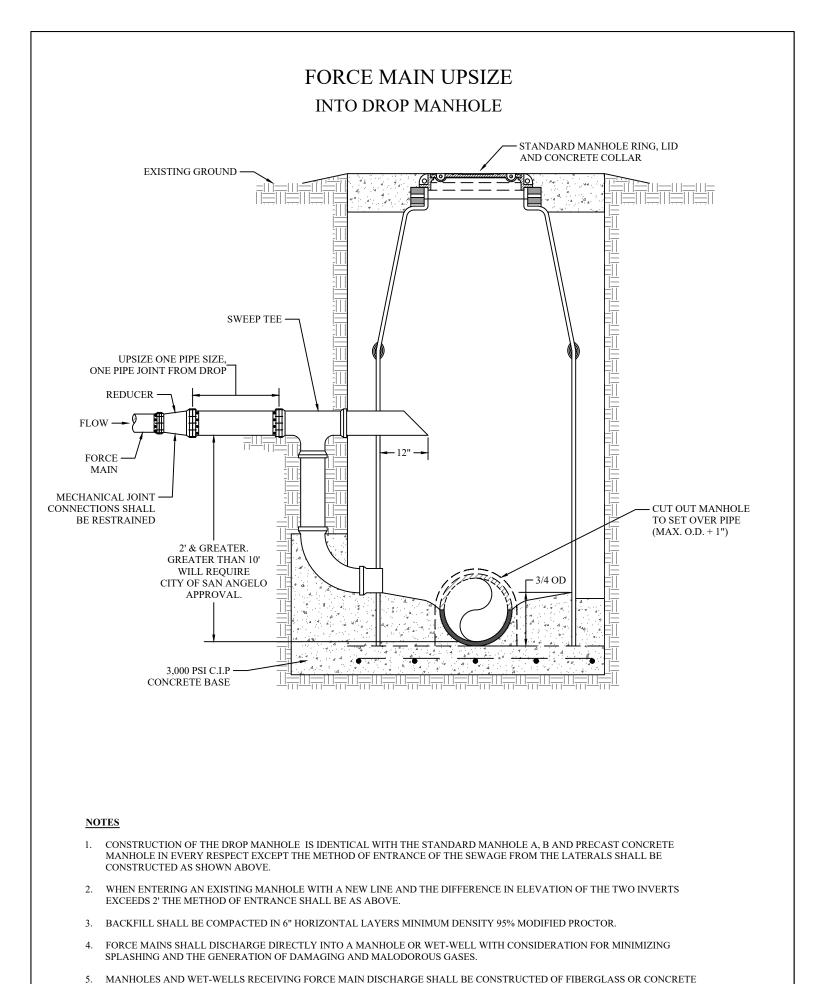


CITY OF SAN ANGELO


FORCE MAIN UPSIZE INTO DROP MANHOLE

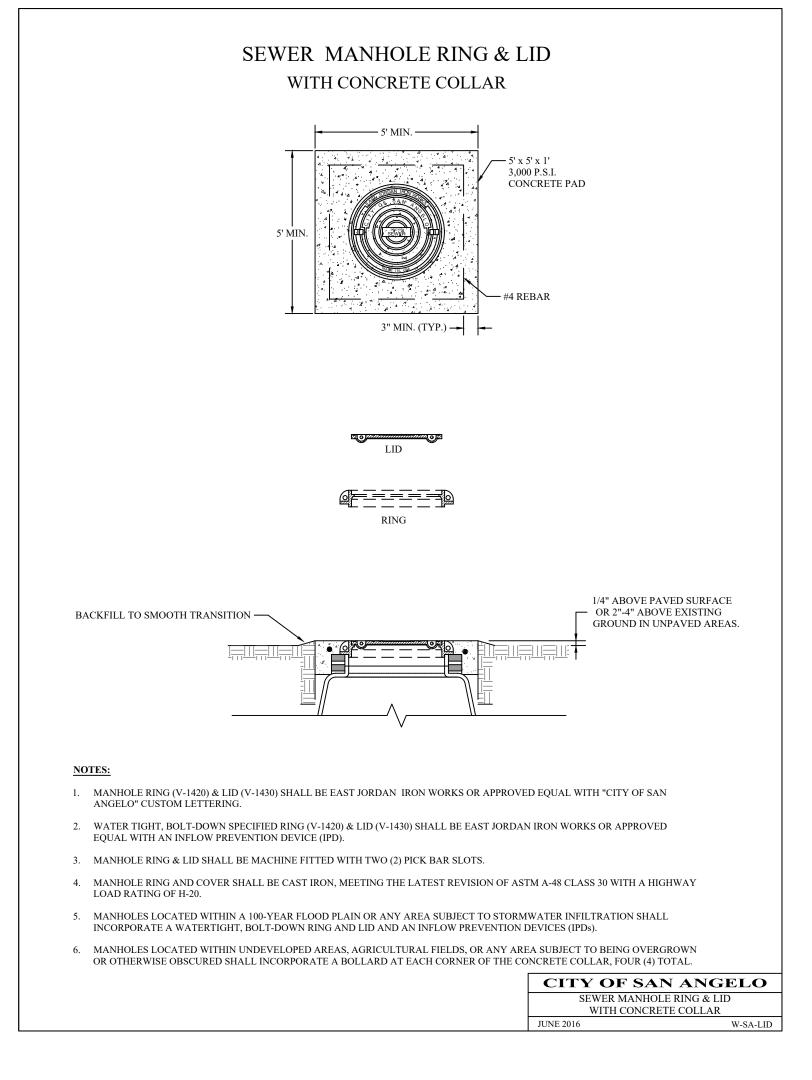

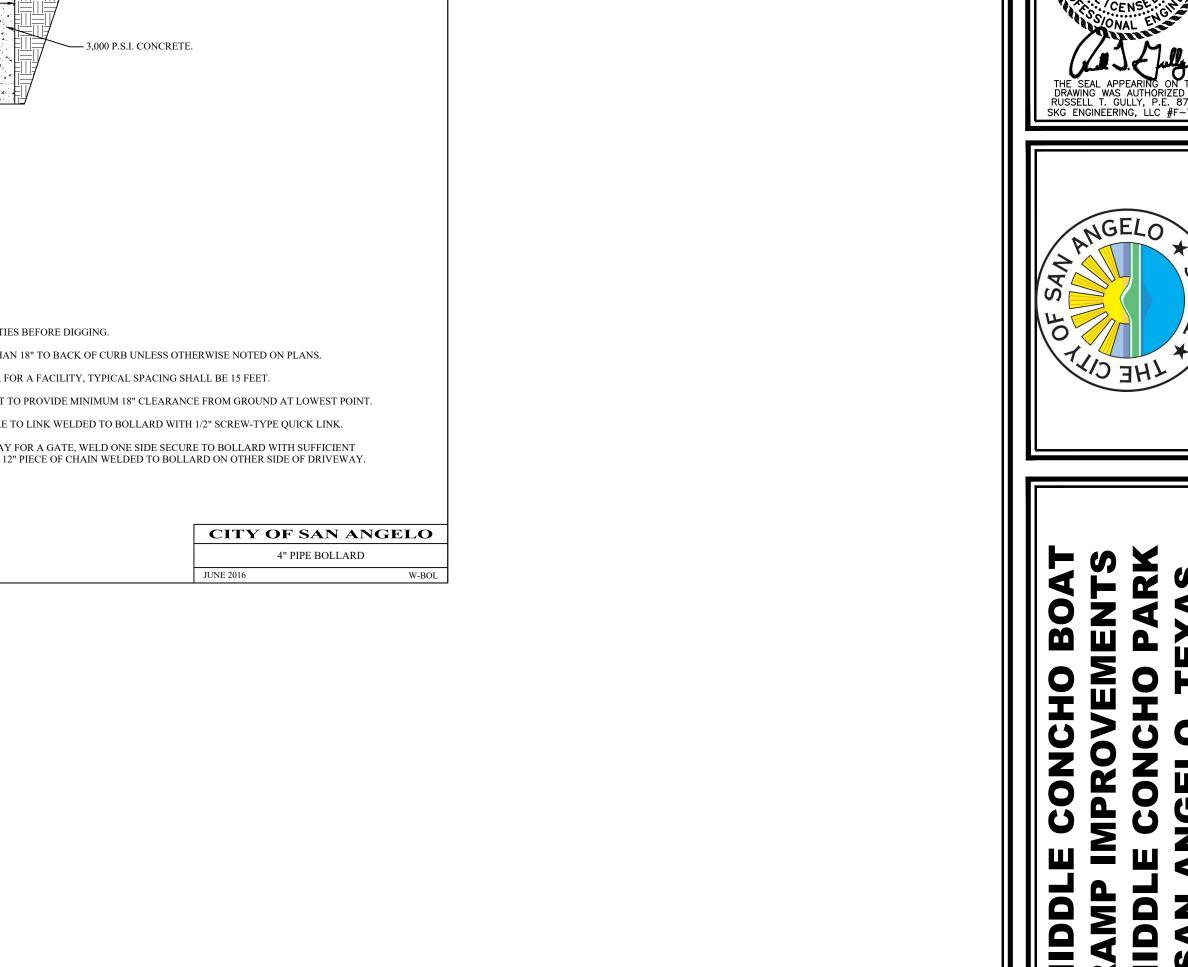


WITH AN APPROVED PROTECTIVE COATING SYSTEM.

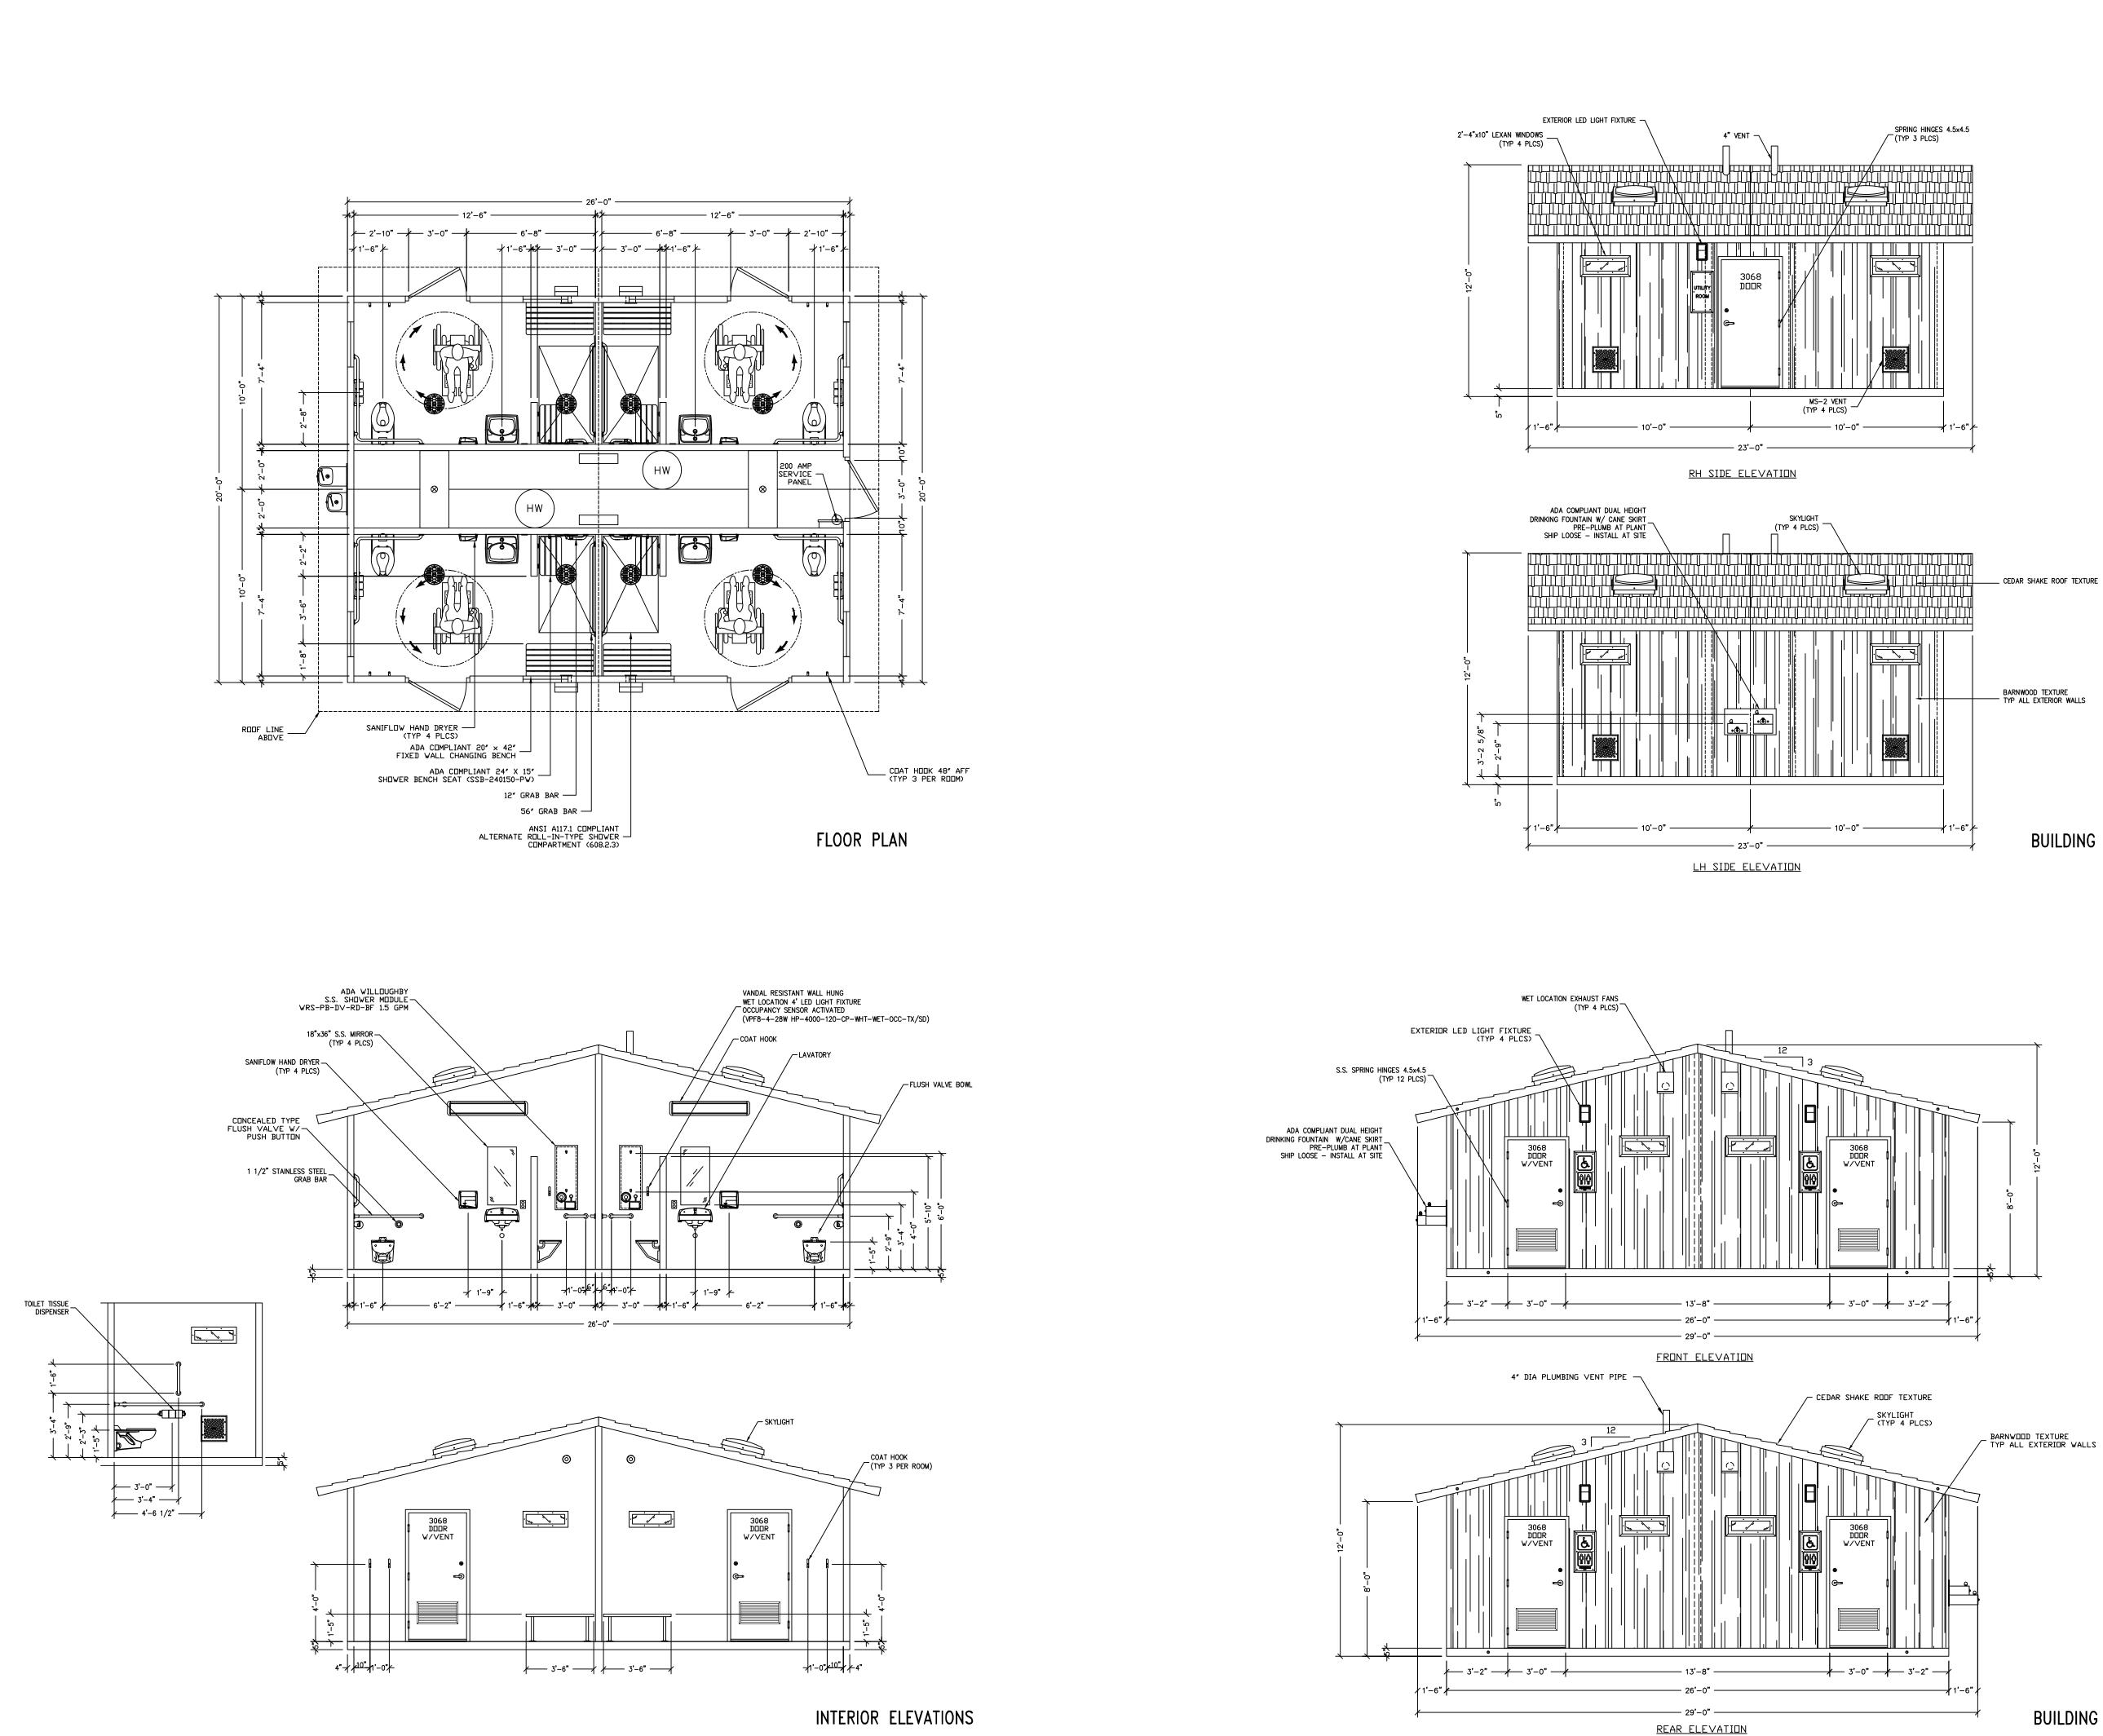

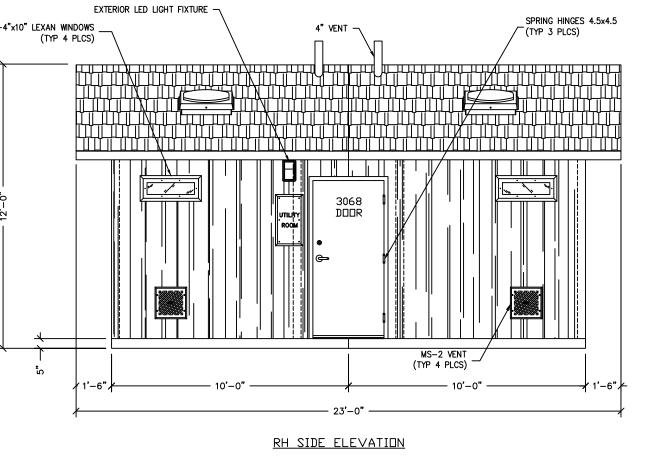

BARNWOOD TEXTURE


TYP ALL EXTERIOR WALLS

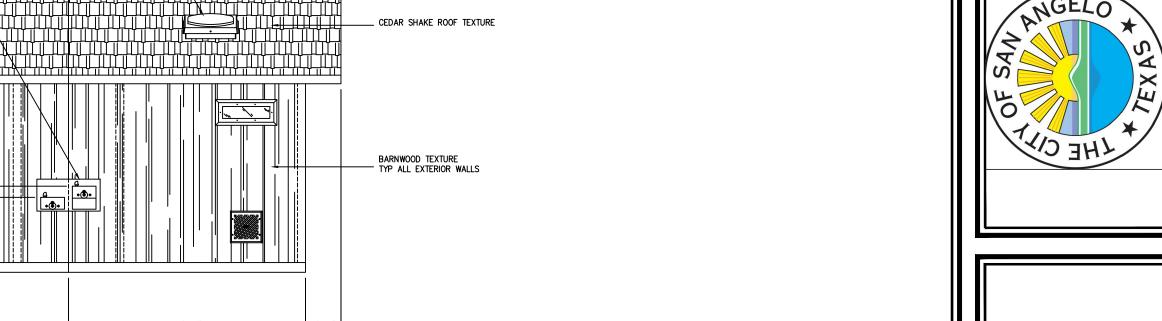


BUILDING ELEVATIONS

**BUILDING ELEVATIONS** 



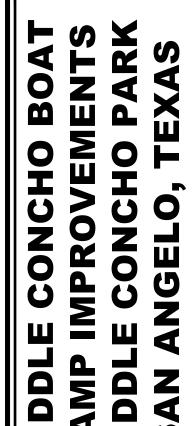

BUILDING

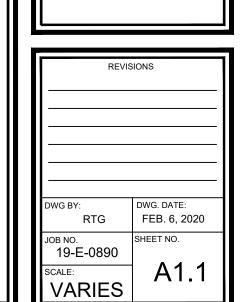

REFERENCE ONLY

3808 N. Sullivan Bldg. #7 Spokane, WA 99216

Precast Products
901 N. Highway 77 Hillsboro, TX 76645

NAVAJO FLUSH / SHOWER
CXT STANDARD BUILDING